




01 EXISTING SITE PLAN
Scale 1:100 @ A1

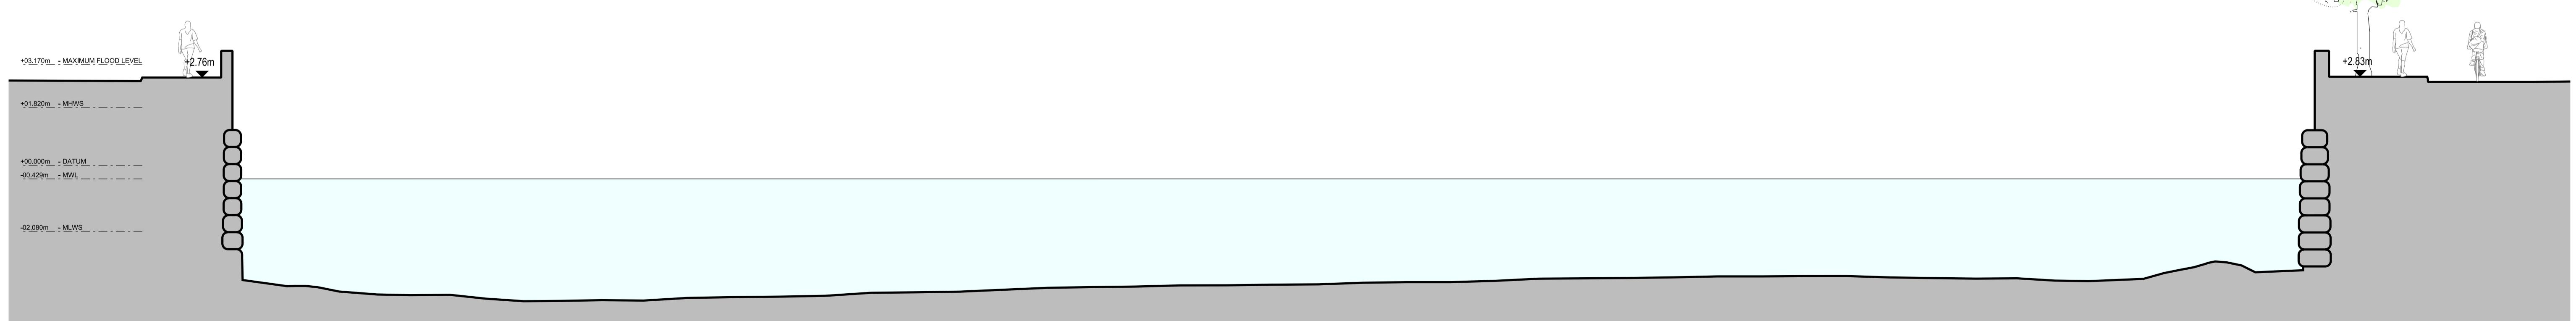

02 EXISTING SITE SECTION
Scale 1:100 @ A1

Do not Scale. Use figured dimensions only. All dimensions to be checked on All drawings to be read in conjunction with the Engineers' drawings.

All drawings to be read in conjunction with the Engineers' drawings.
Any discrepancies between consultants drawings to be reported.

The Contractor's attention is drawn to the Health & Safety matters identified in the Health & Safety plan as below:

The Contractor's attention is drawn to the Health & Safety matters outlined in the Health & Safety plan as being potentially hazardous. These items should not be considered as a complete and final list. The Work Package Contractor's normal Health and Safety obligations still apply when undertaking constructional operations both on and off site.

The Work Package Contractor's normal Health and Safety obligations still apply when undertaking constructional operations both on site and off site.

A horizontal line representing a 10m span, divided into segments. The segments are labeled as follows:

- Segment 0: 0m to 1m, black with a checkered pattern at the start.
- Segment 1: 1m to 2m, solid black.
- Segment 2: 2m to 3m, solid black.
- Segment 3: 3m to 4m, solid black.
- Segment 4: 4m to 5m, solid black.
- Segment 5: 5m to 6m, solid black.
- Segment 6: 6m to 10m, solid black.

DRAFT



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WilkinsonEyre


Wilkinson Eyre Architects
33 Bowling Green Lane, London
EC1R 2QB, United Kingdom

Project
Title: **Smart Project Title (Smart Project)**


Harley Street Pedestrian/Cycle Bridge

Drawing Title

scale at A1
:100

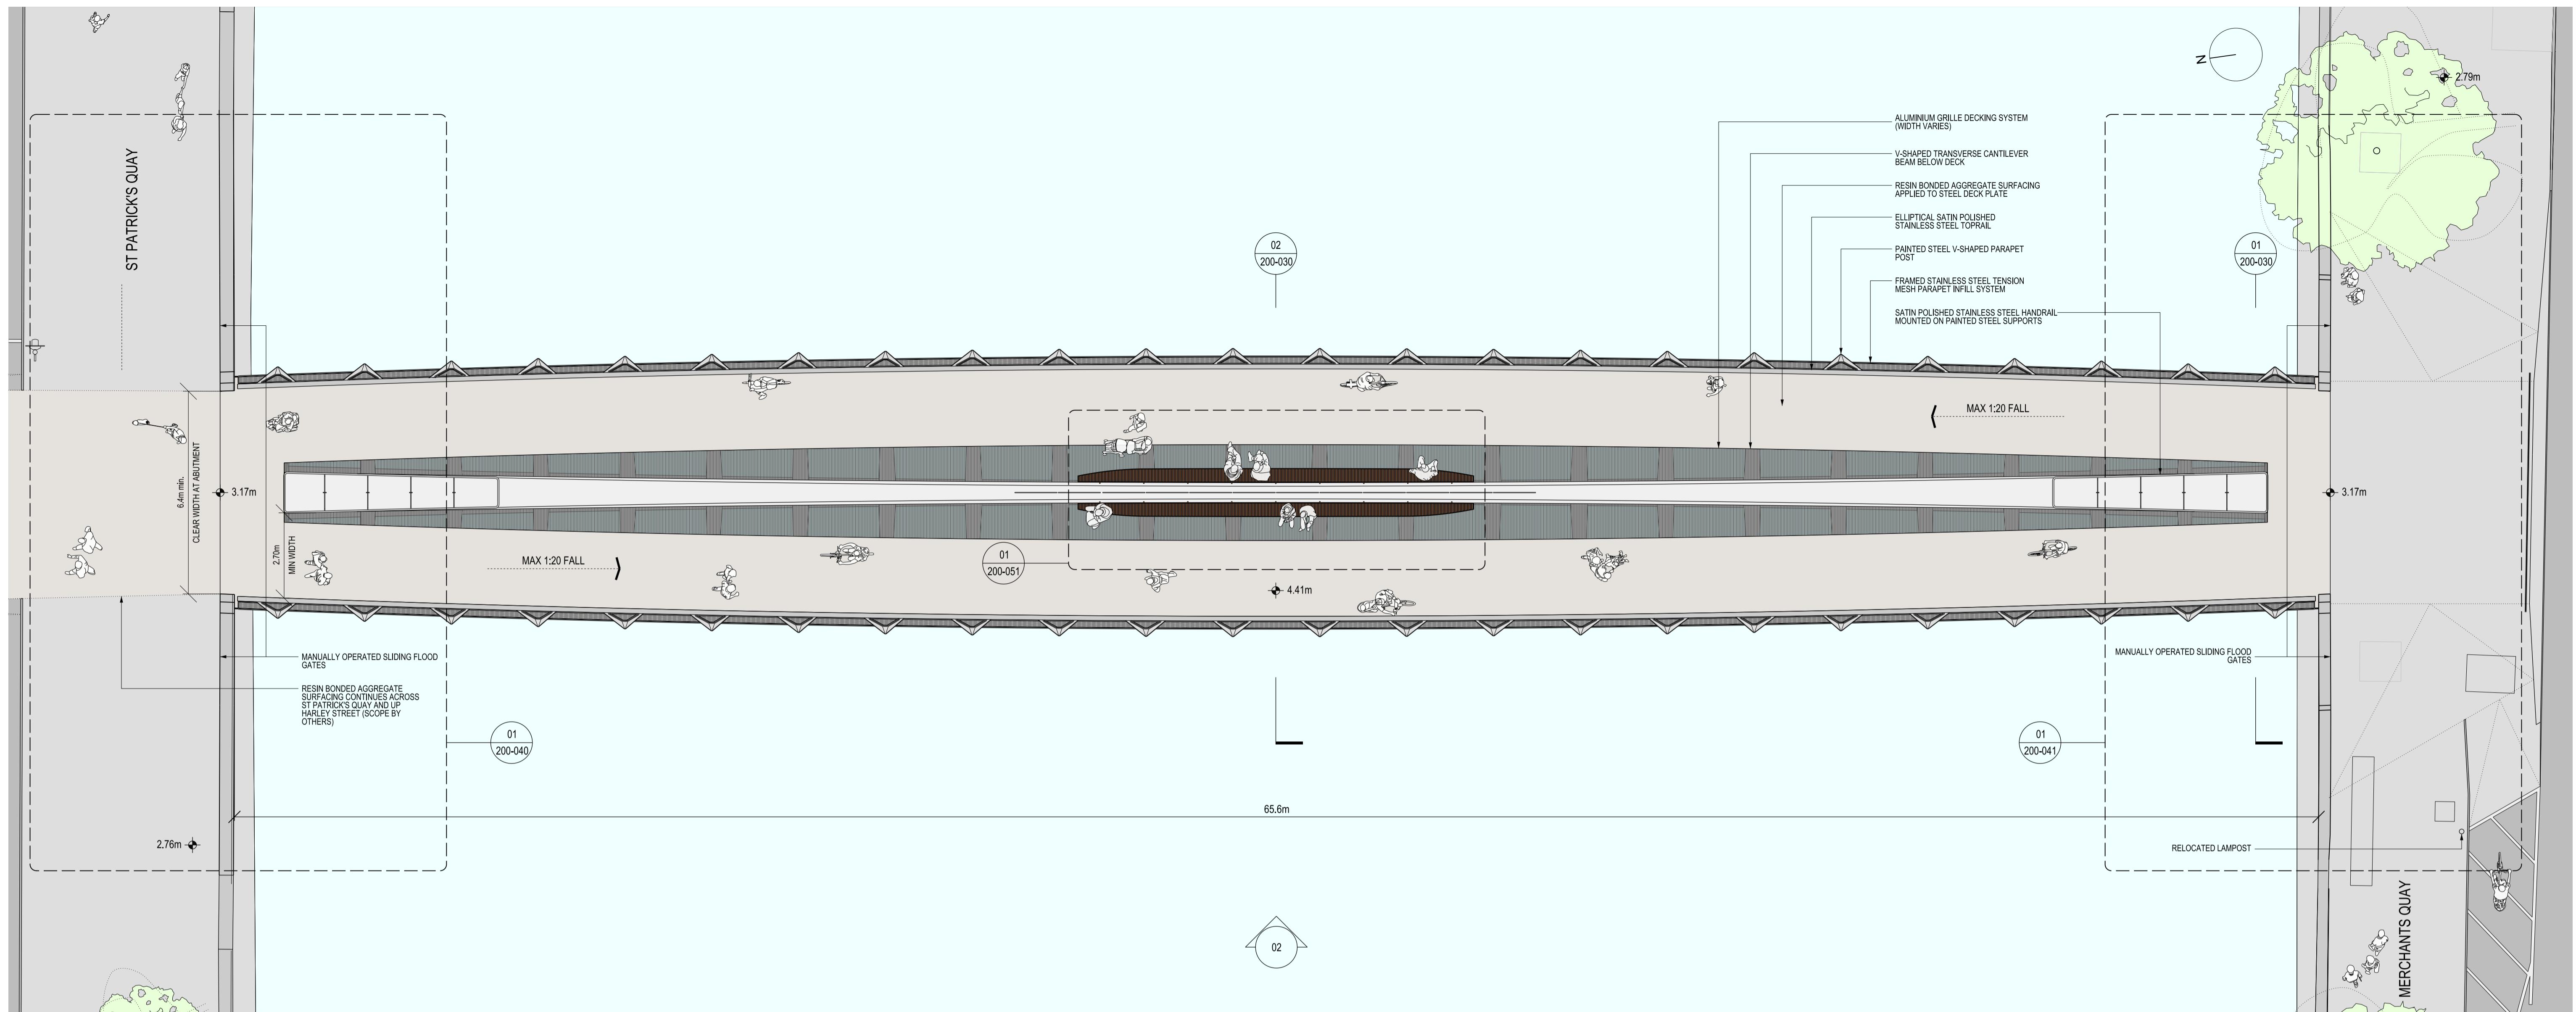

01 BRIDGE PLAN
Scale 1:100 @ A1

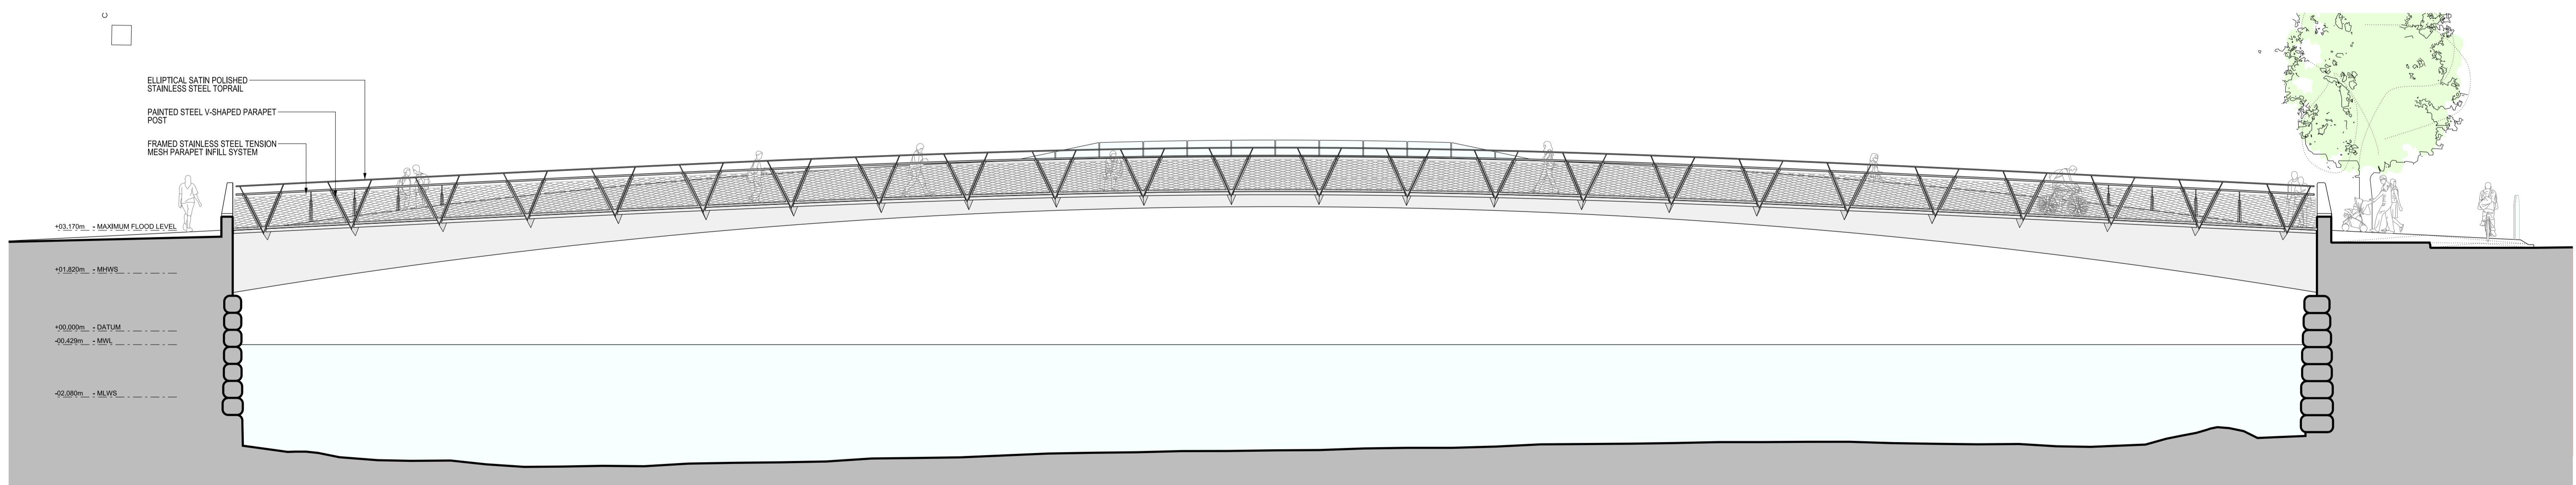

02 BRIDGE ELEVATION
Scale 1:100 @ A1

Do not Scale. Use figured dimensions only. All dimensions to be checked on site.
All drawings to be read in conjunction with the Engineers' drawings.

All drawings to be read in conjunction with the Engineering drawings.
Any discrepancies between consultants drawings to be resolved by the engineer.

The Contractor's attention is drawn to the Health & Safety matters identified in the Health & Safety plan contained in the Contract.

The Contractor's attention is drawn to the Health & Safety matters identified in the Health & Safety plan as being of concern. These items should not be considered as a complete and final list.

The Work Package Contractor's normal Health and Safety obligations still apply when undertaking constructional operations both on and off site.

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Wilkinson Eyre Architects
33 Bowling Green Lane, London
EC1R 0BJ, United Kingdom

Project
Harley Street Pedestrian/Cycle Bridge

Drawing Title


Proposed Bridge Plan & Elevation

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Scale at A1
1:100


Drawing and CAD File Number
253690-B-200-010

WilkinsonEyre Architects Ltd

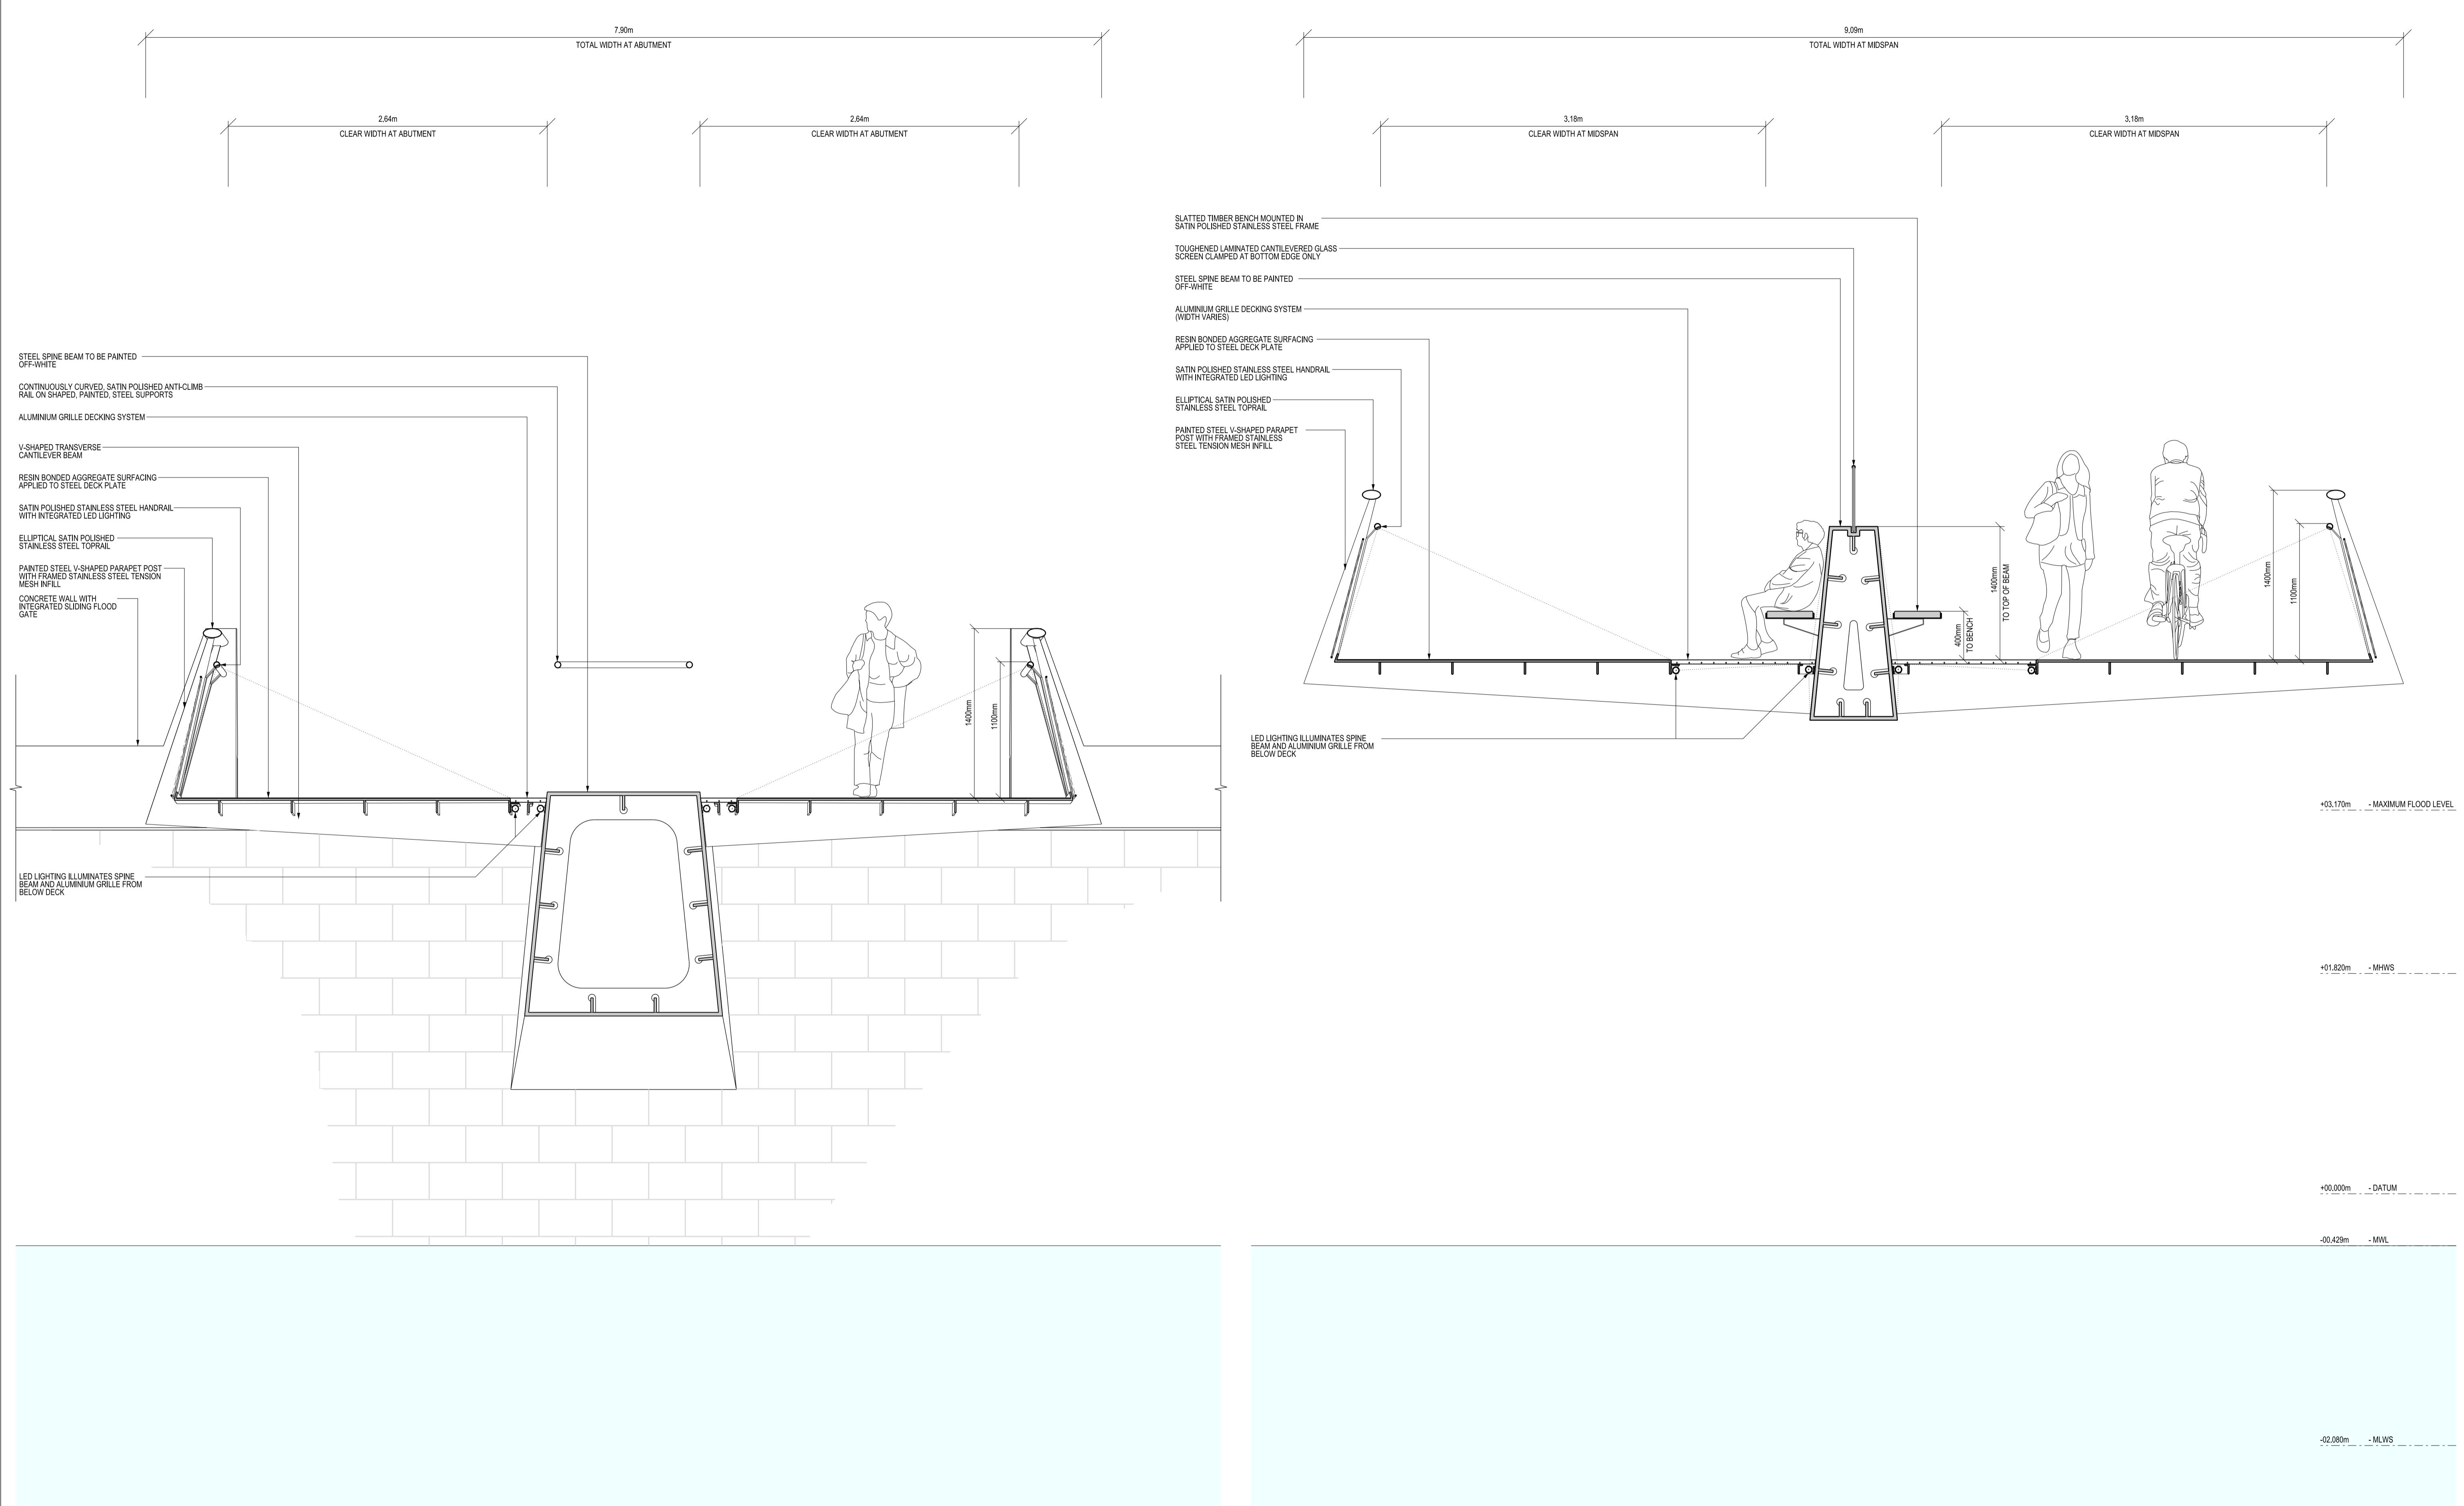

01 SECTION AT ABUTMENT
Scale 1:25 @ A1


Rev	Date	Description	By	Chkd	Issue Status	Client	ARUP	WilkinsonEyre	Project
-	-	-	-	-	Do not Scale. Use figured dimensions only. All dimensions to be checked on site				Harley Street Pedestrian/Cycle Bridge
-	-	-	-	-	All drawings to be read in conjunction with the Engineers' drawings.				Drawing Title
-	-	-	-	-	Any discrepancies between consultants drawings to be reported to the Architect before any work commences.				Proposed Bridge Cross-sections
-	-	-	-	-	The Contractor's attention is drawn to the Health & Safety matters identified in the Health & Safety plan as being potentially hazardous.				Scale at A1
-	-	-	-	-	These items should not be considered as a complete and final list.				Drawing and CAD File Number
-	-	-	-	-	The Work Package Contractor's normal Health and Safety obligations still apply when undertaking constructional operations both on and off site.				1:25
-	-	-	-	-					Rev -
-	-	-	-	-					

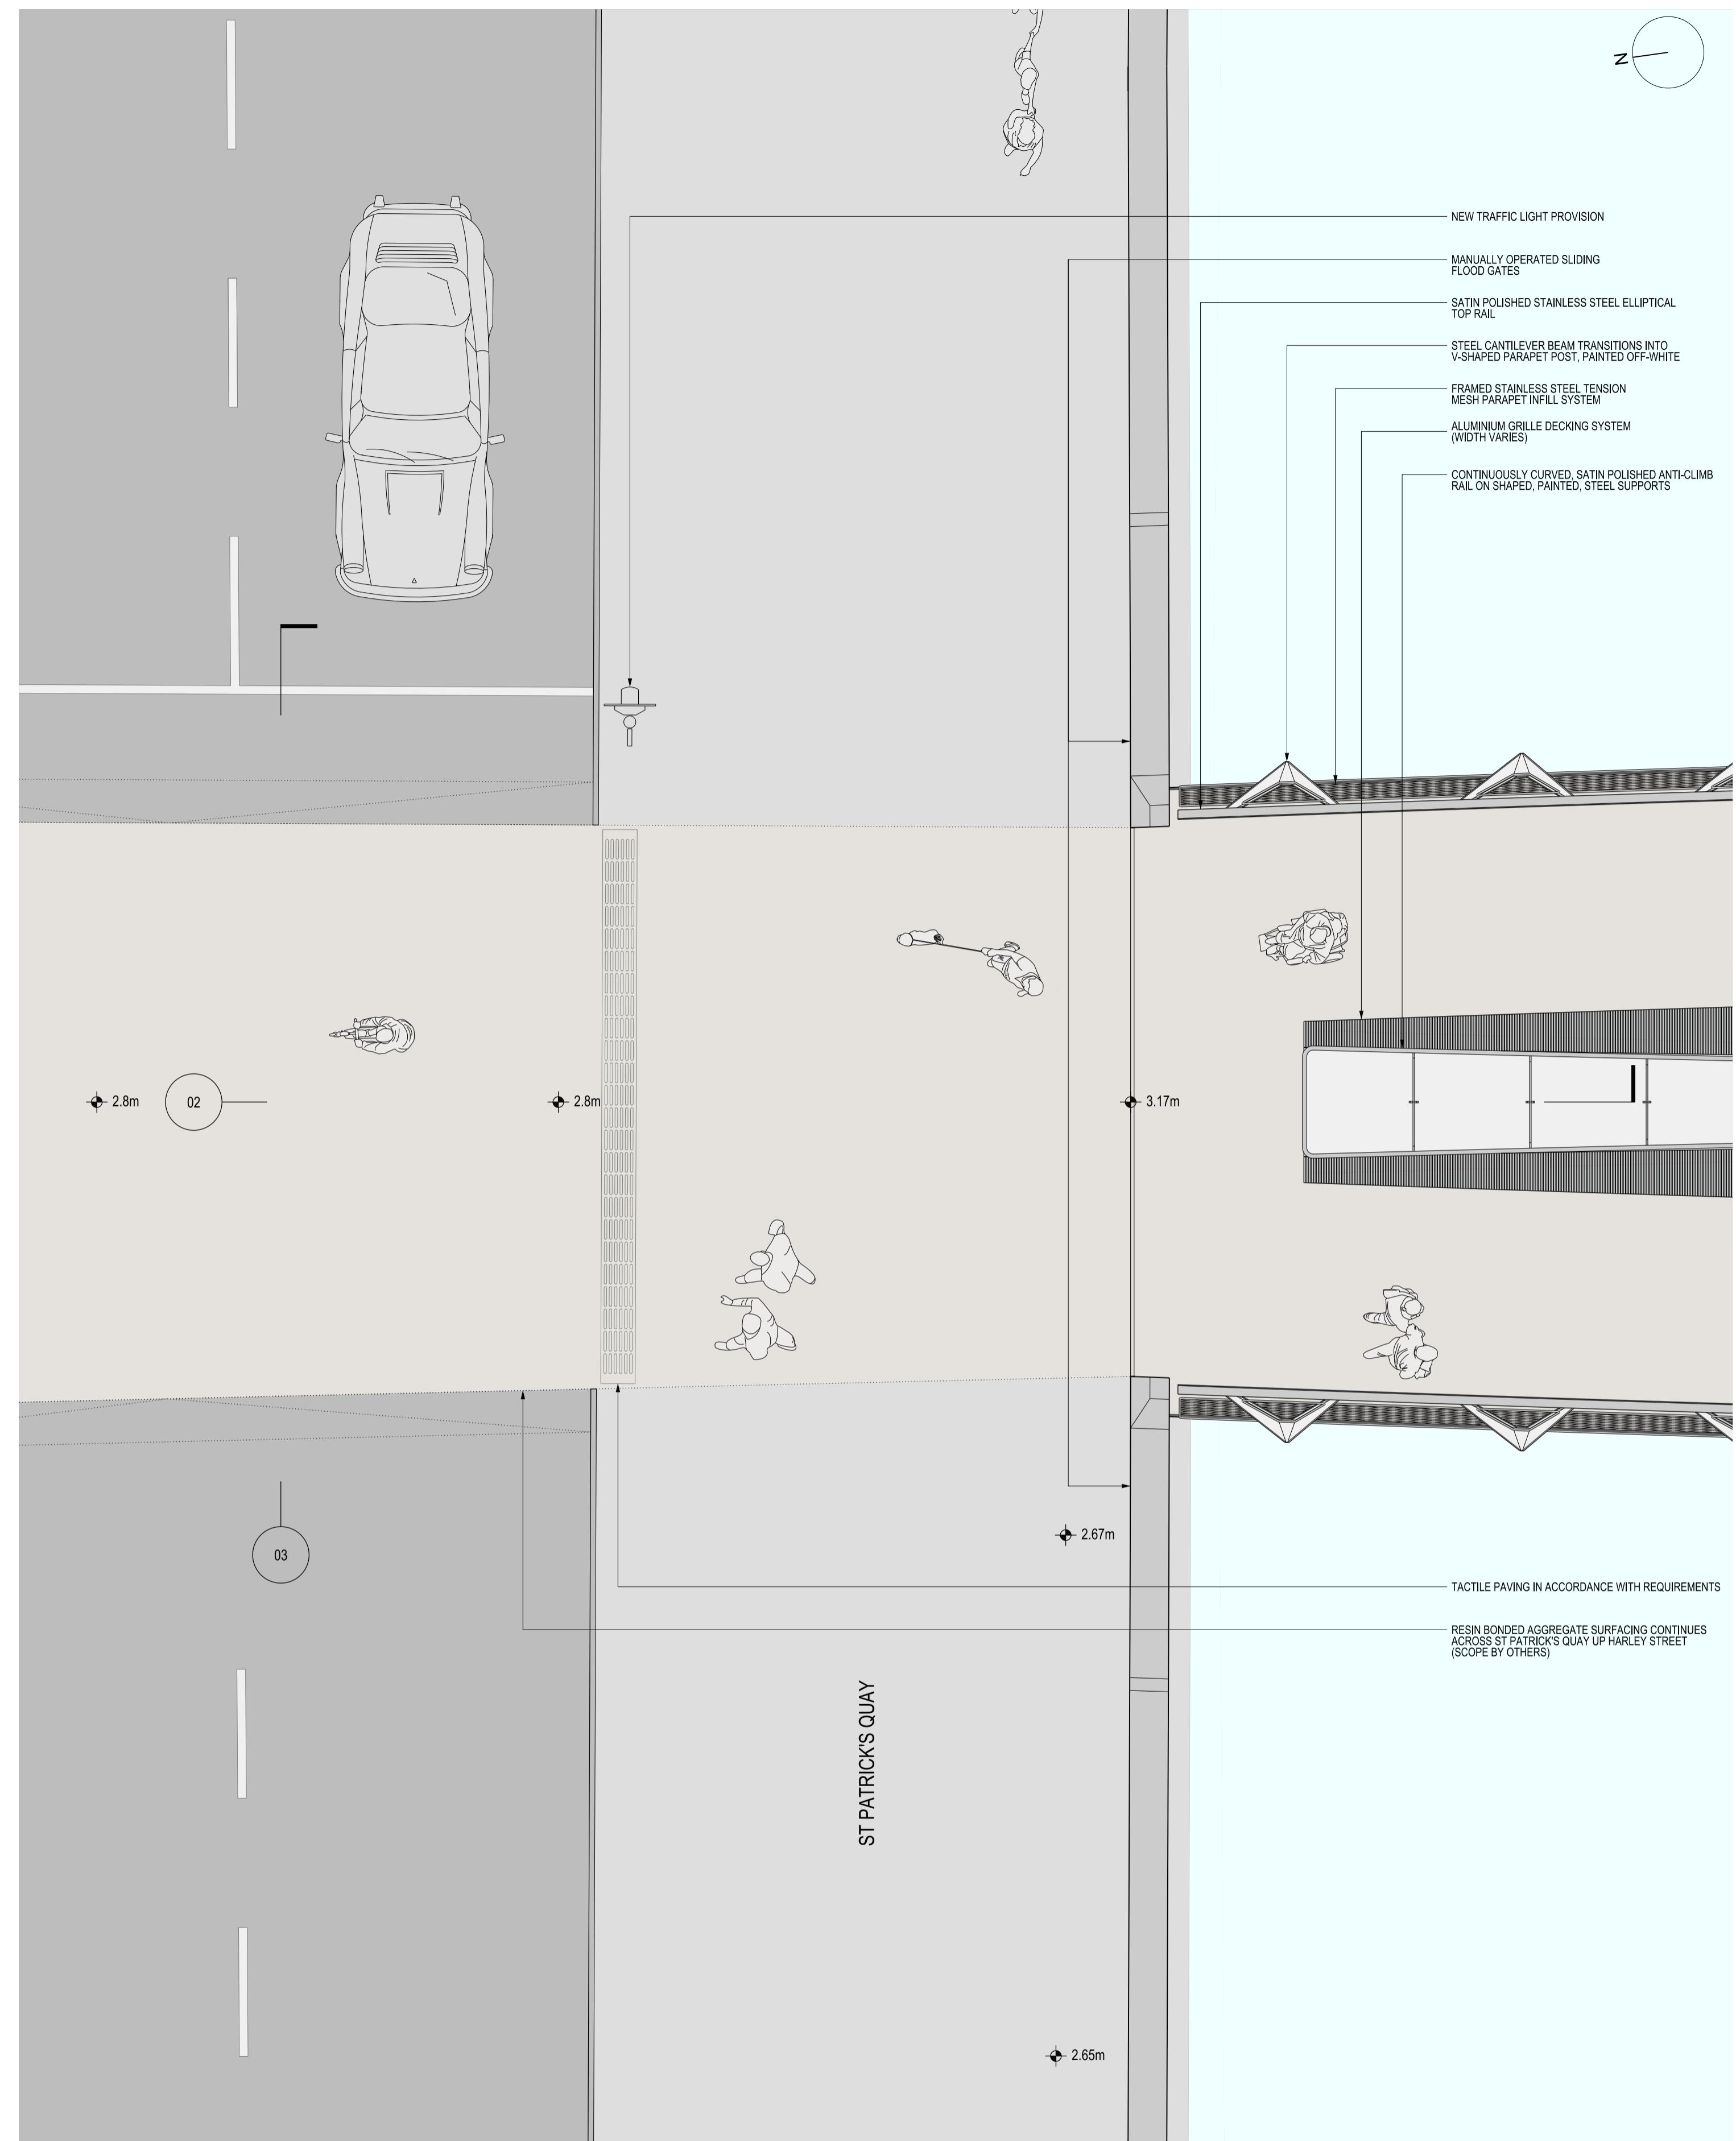


01 PLAN OF NORTH ABUTMENT
Scale 1:50 @ A1

Rev	Date	Description	By	Chkd
-	-	Do not Scale. Use figured dimensions only. All dimensions to be checked on site	-	-
-	-	All drawings to be read in conjunction with the Engineers' drawings	-	-
-	-	Any discrepancies between consultants drawings to be reported to the Architect before any work commences	-	-
-	-	The Contractor's attention is drawn to the Health & Safety matters identified in the Health & Safety plan as being potentially hazardous	-	-
-	-	These items should not be considered as a complete and final list	-	-
-	-	The Work Package Contractor's normal Health and Safety obligations still apply when undertaking constructional operations both on and off site	-	-

02 SECTION AT NORTH ABUTMENT
Scale 1:50 @ A1

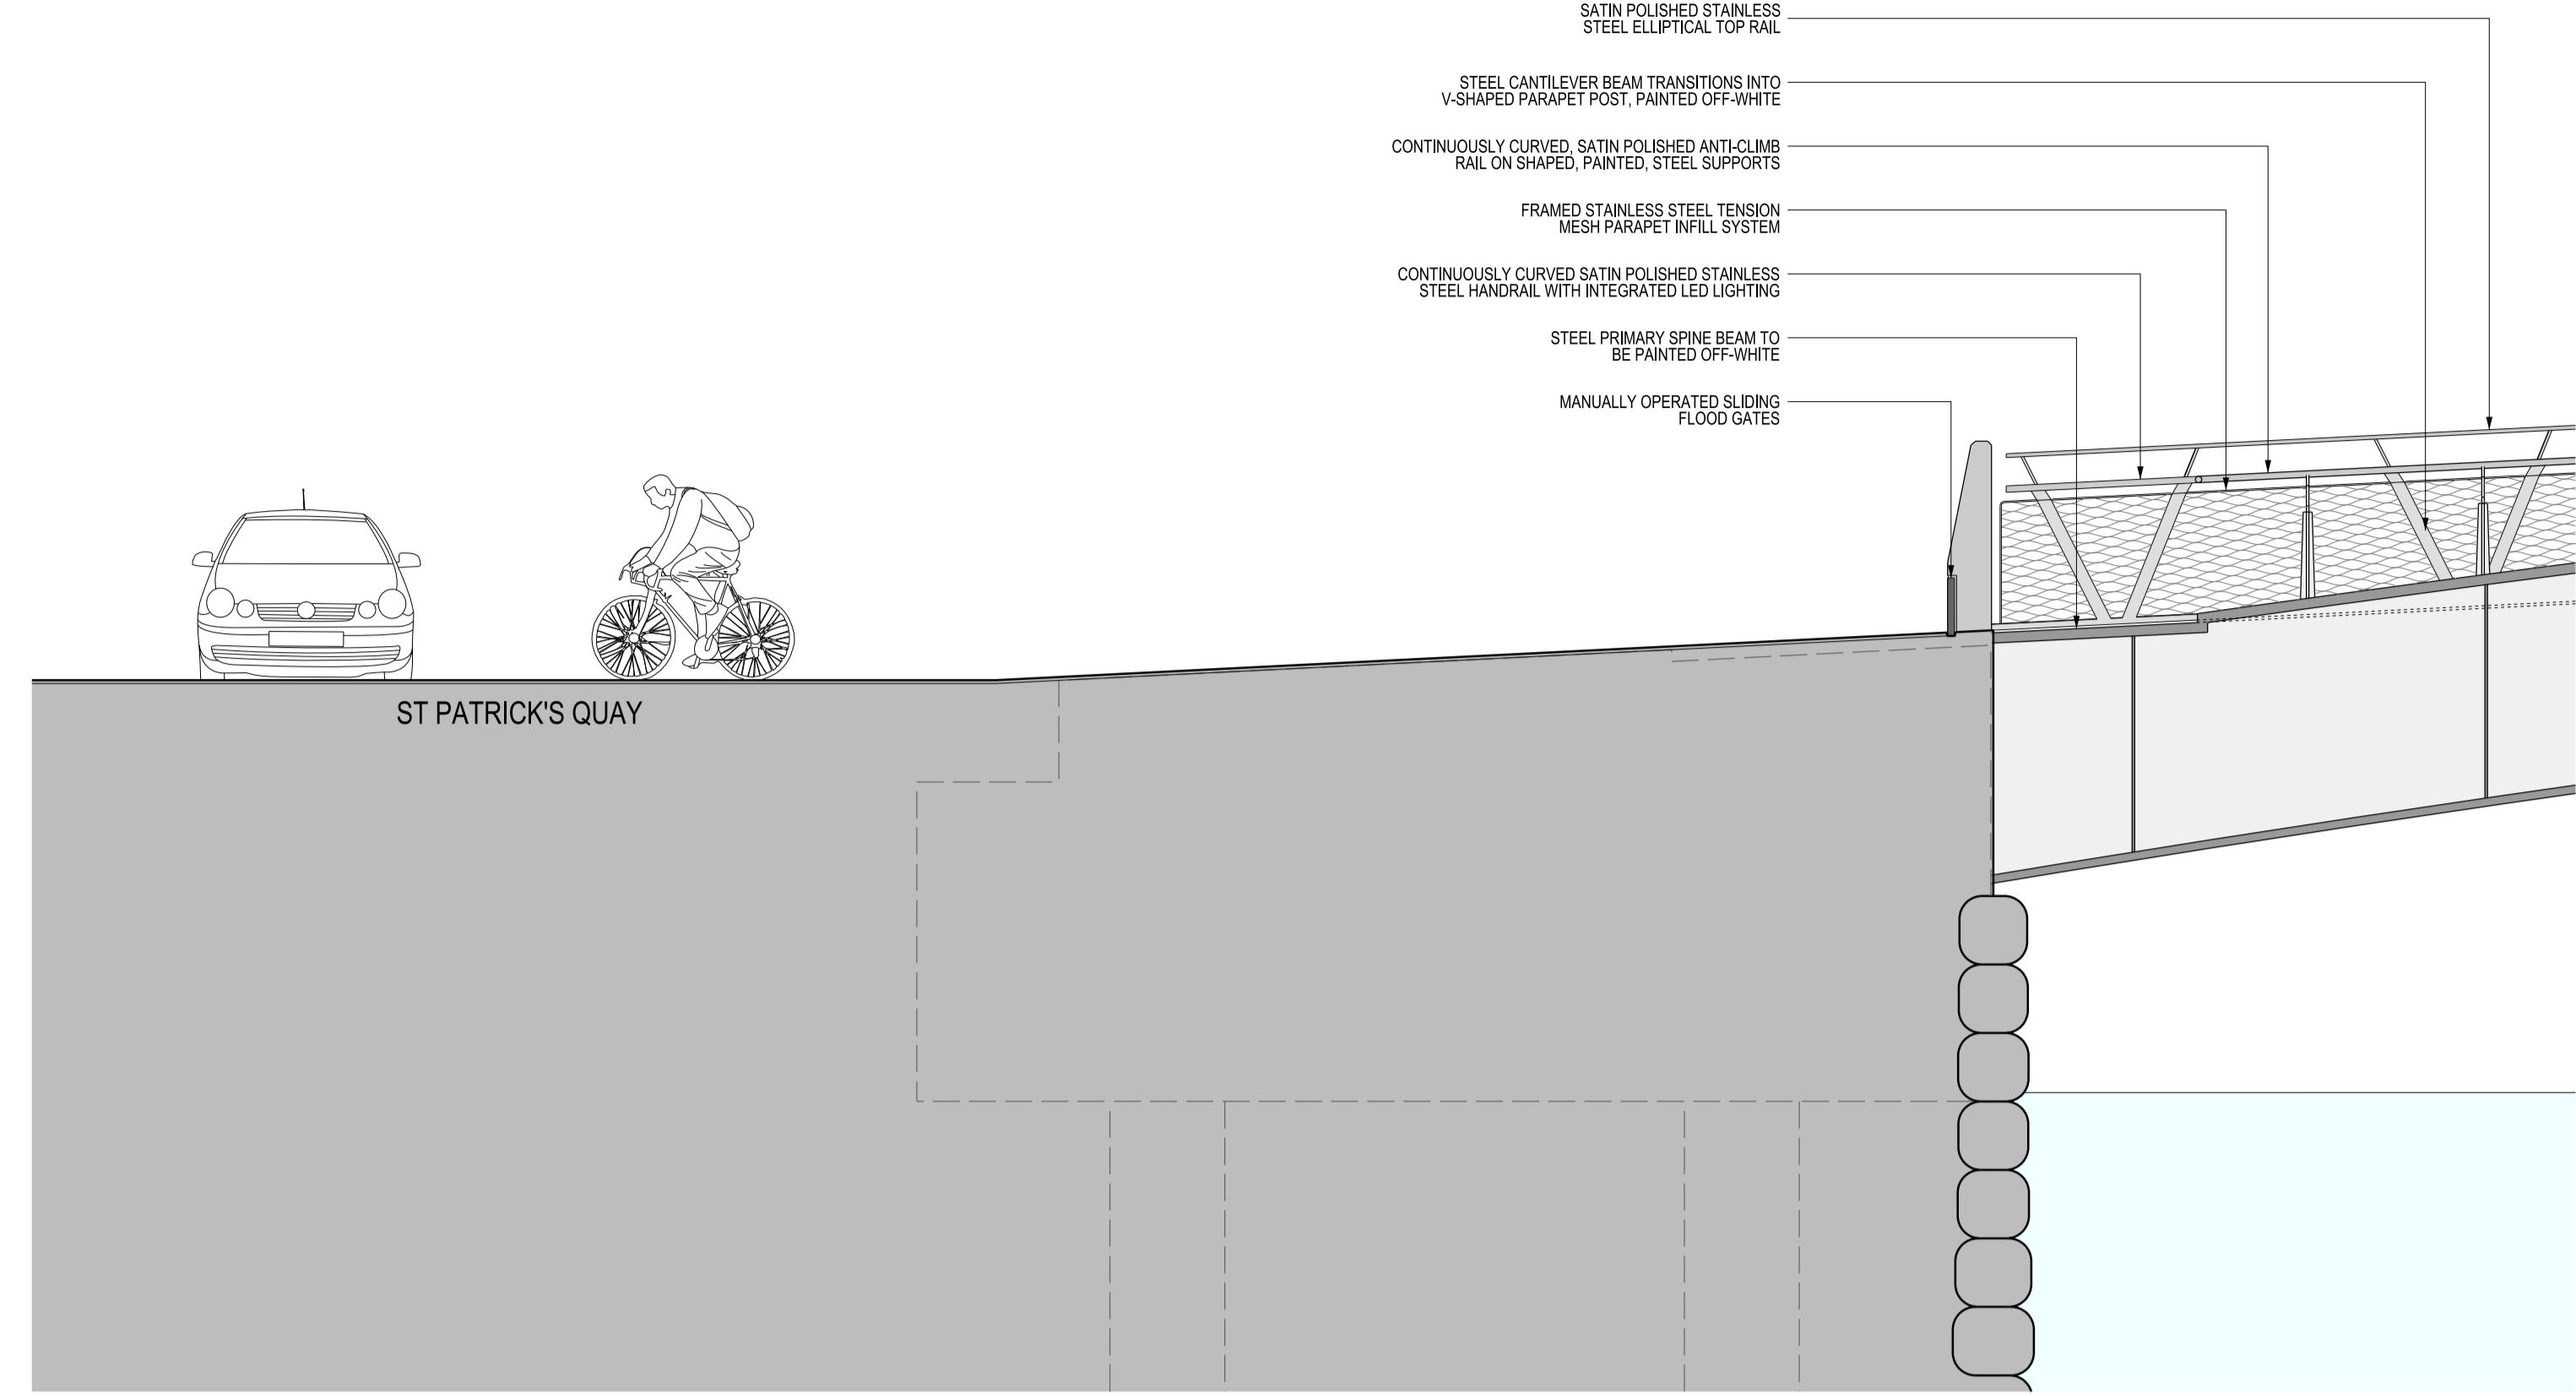

03 SECTION THROUGH NORTH ABUTMENT
Scale 1:50 @ A1

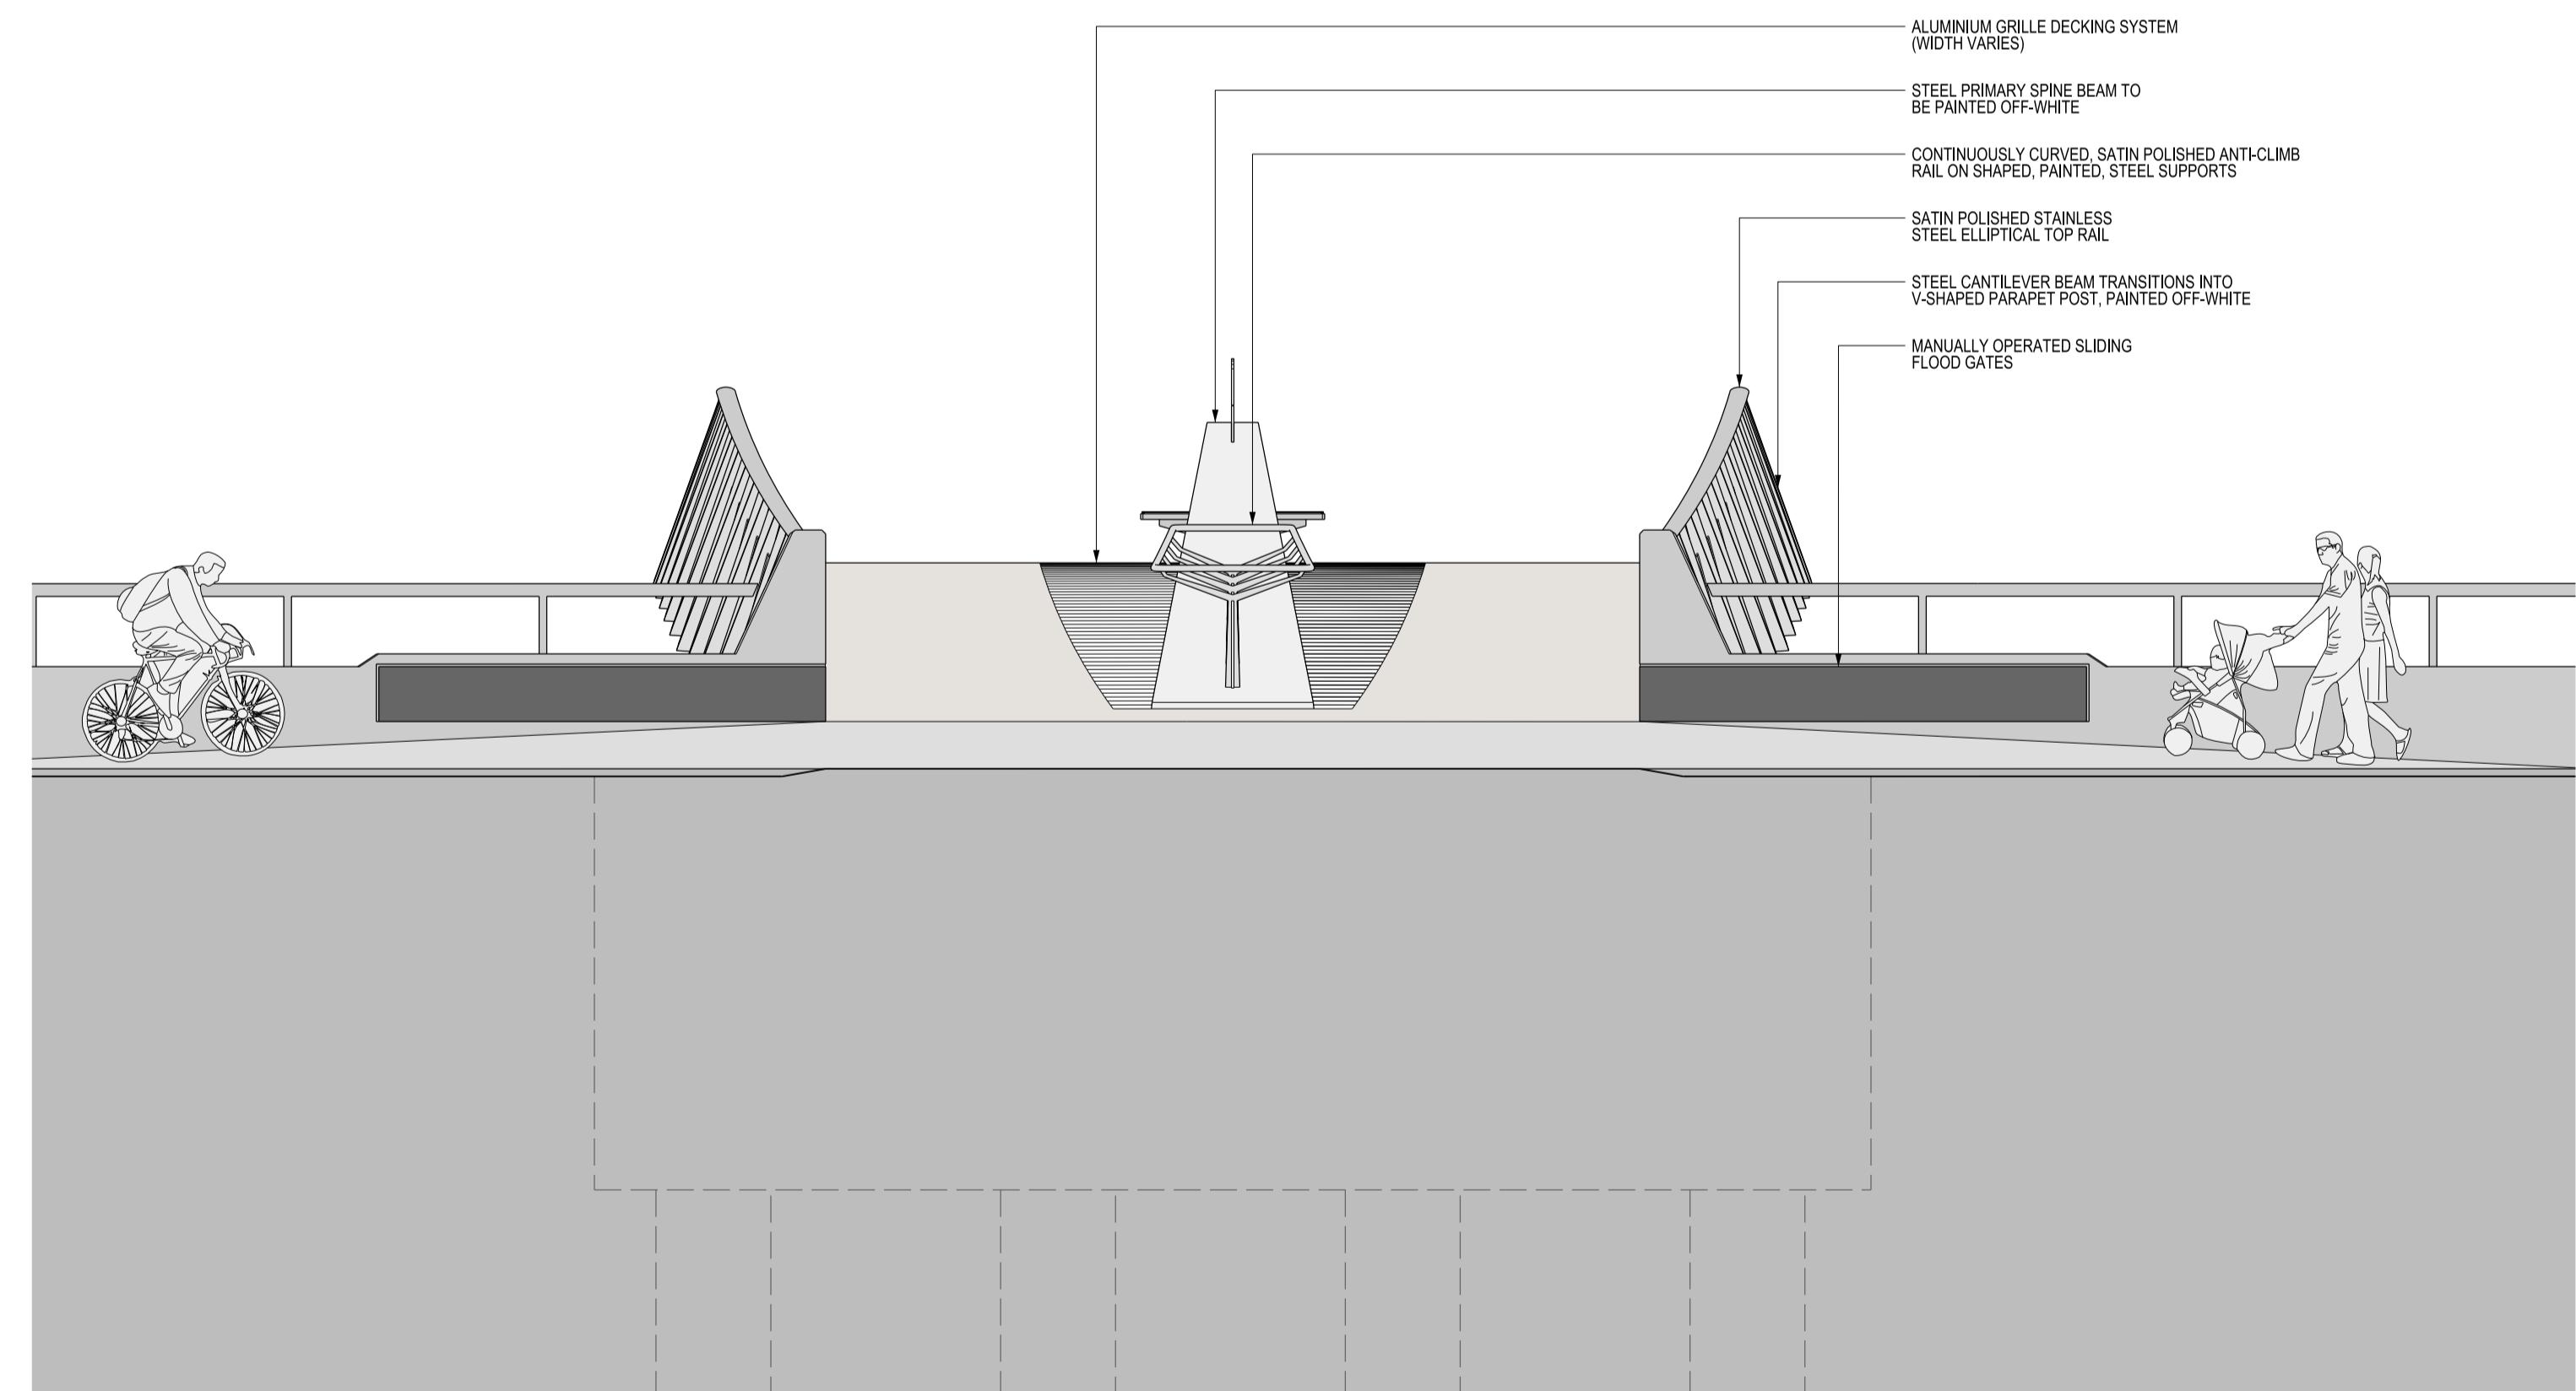

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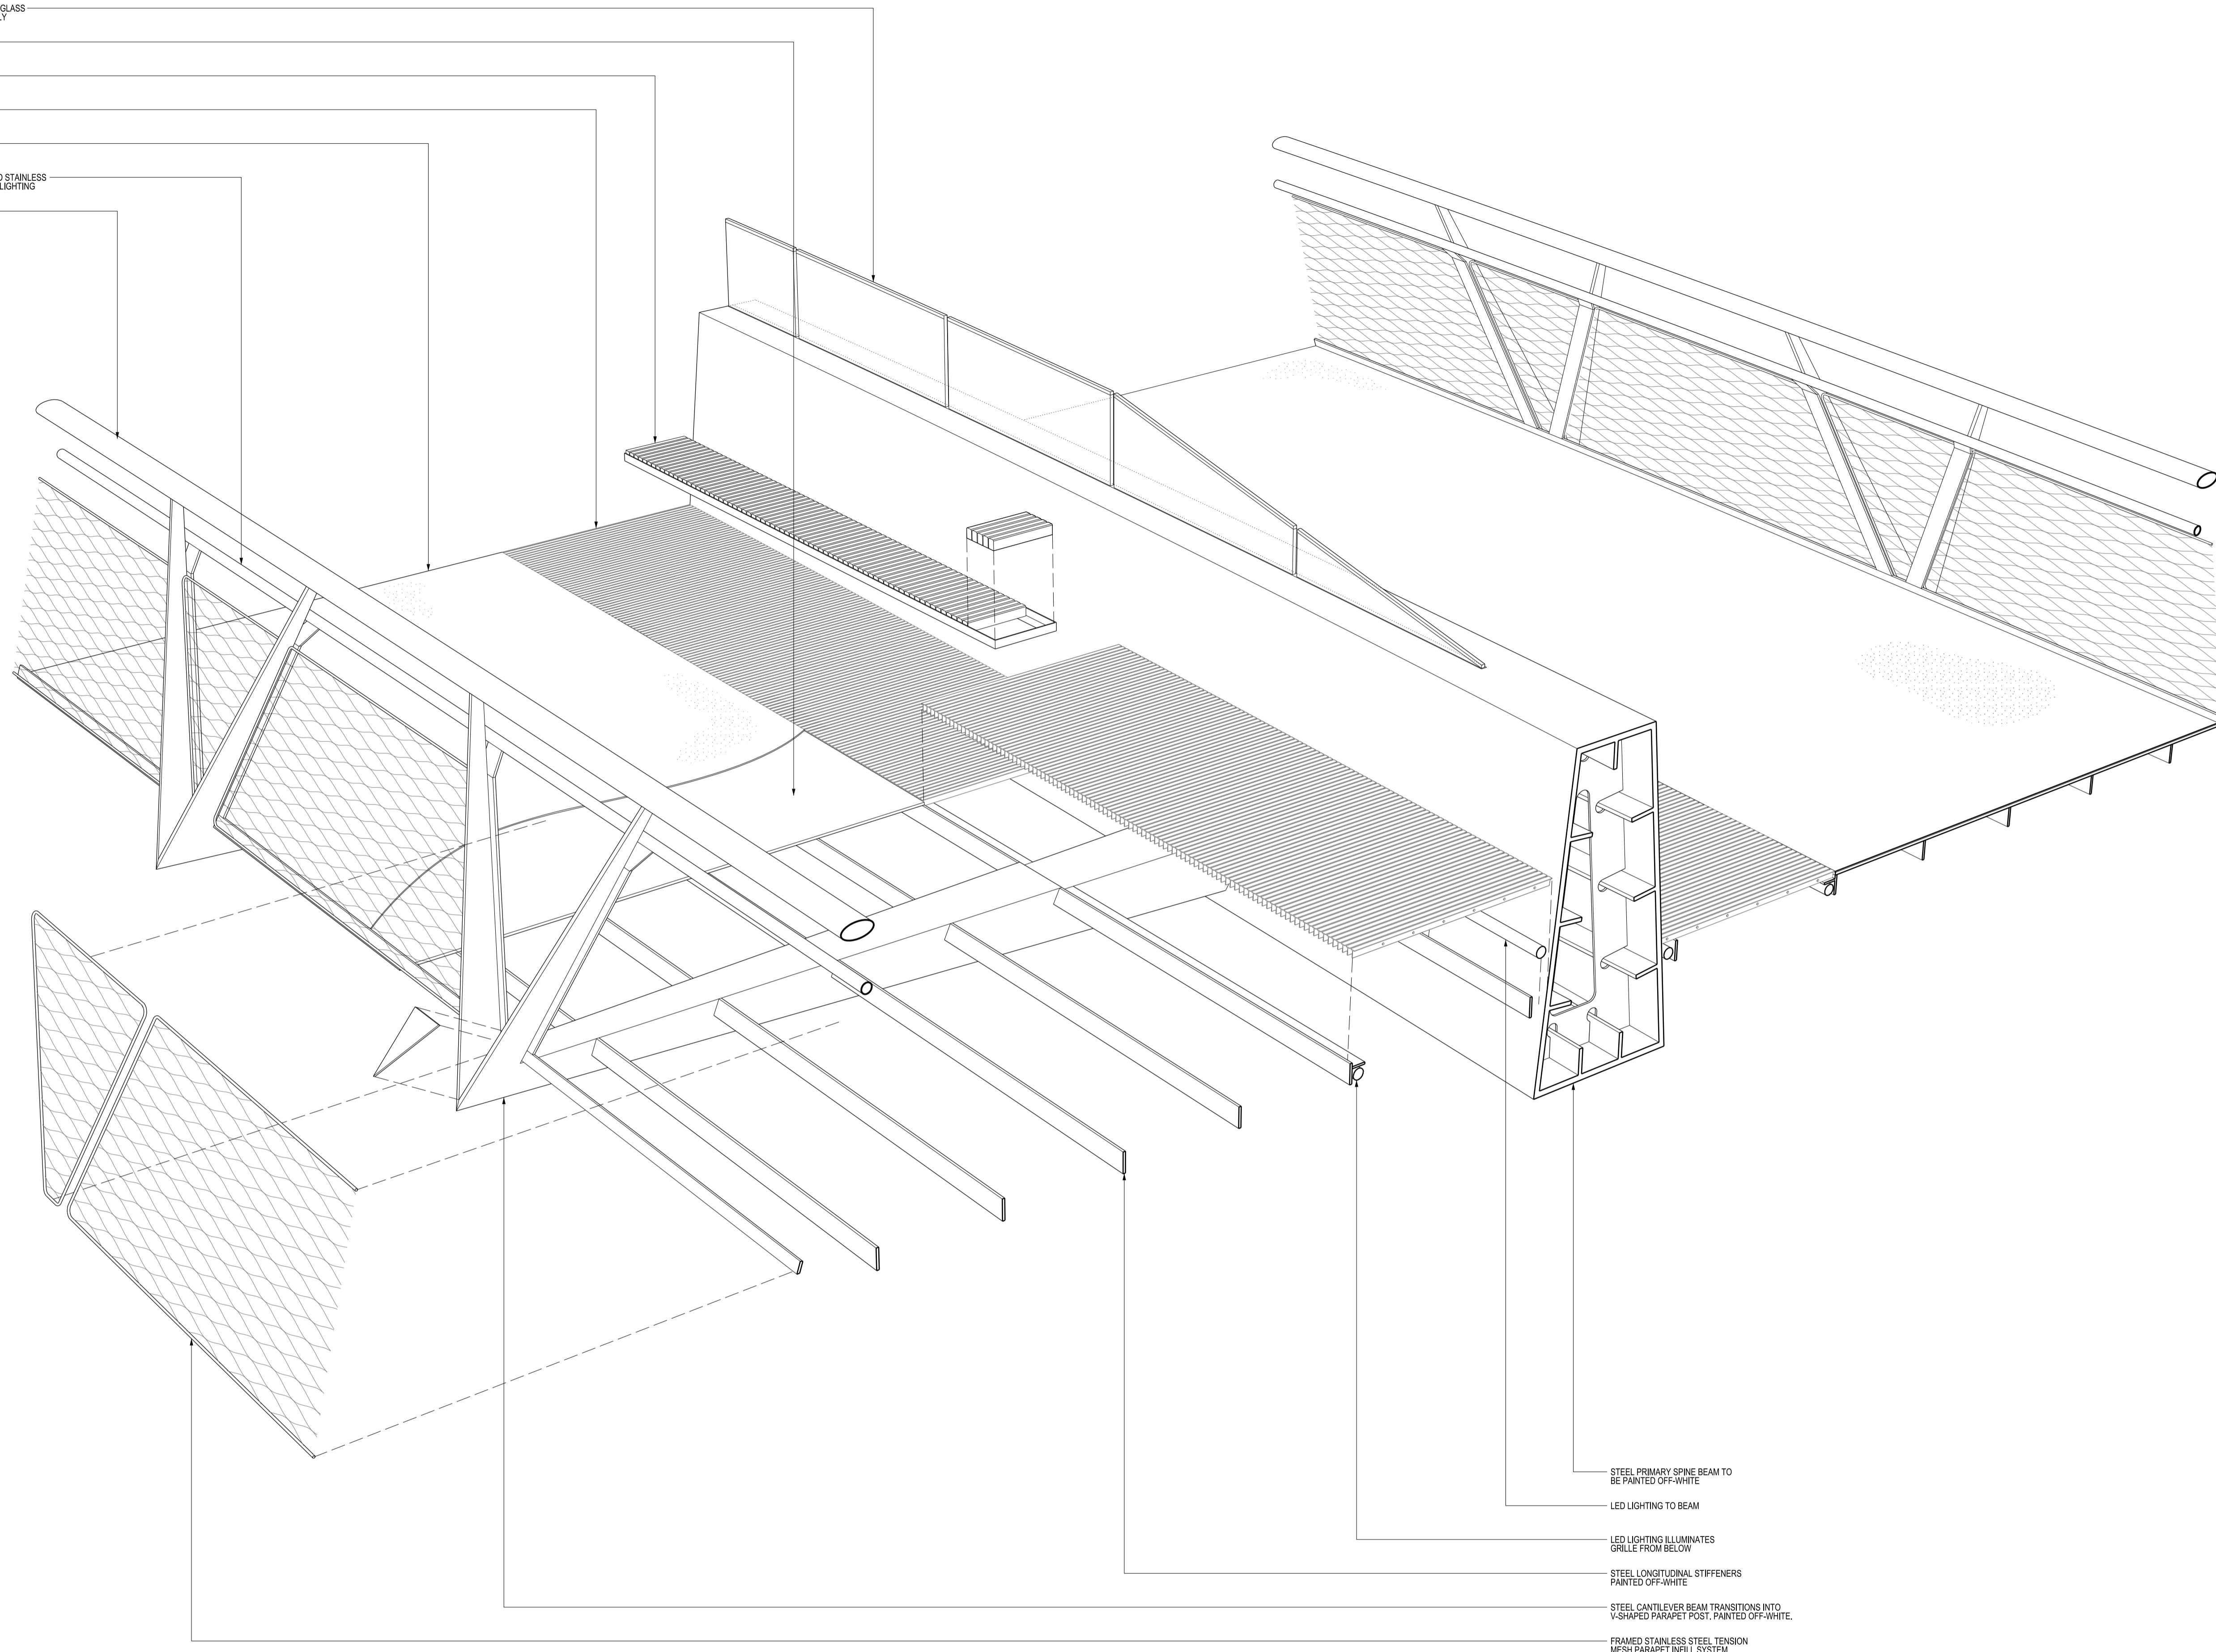


ARUP

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Project	Harley Street Pedestrian/Cycle Bridge
Drawing Title	Proposed North Abutment
Proposed North Abutment	St Patrick's Quay
Scale at A1	1:50
Drawing and CAD File Number	253690-B-200-040
Rev	-



01 EXPLODED PERSPECTIVE NTS

Do not Scale. Use figured dimensions only. All dimensions to be checked on site.


All drawings to be read in conjunction with the Engineers' drawings
Any discrepancy between consultants drawings to be reported to

Any discrepancies between consultants drawings to be reported to the Architect before any work commences.

The Contractor's attention is drawn to the Health & Safety matters identified in the Health & Safety plan as being of particular importance. These items should not be considered as a complete and final list.

The Work Package Contractor's normal Health and Safety obligations still apply when undertaking constructional operations both on and off site.

DRA

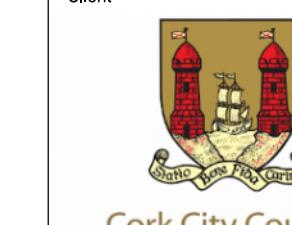

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33 Bowling Green Lane, London
EC1R 0B, United Kingdom

Project

Harley Street Pedestria

Drawing Title

Exploded Perspective



STEELWORK PAINTED OFF-WHITE



TENSION MESH PARAPET INFILL




HANDRAIL WITH INTEGRATED LIGHTING



BENCH



RESIN BONDED AGGREGATE SURFACING AND ALUMINIUM GRILLE

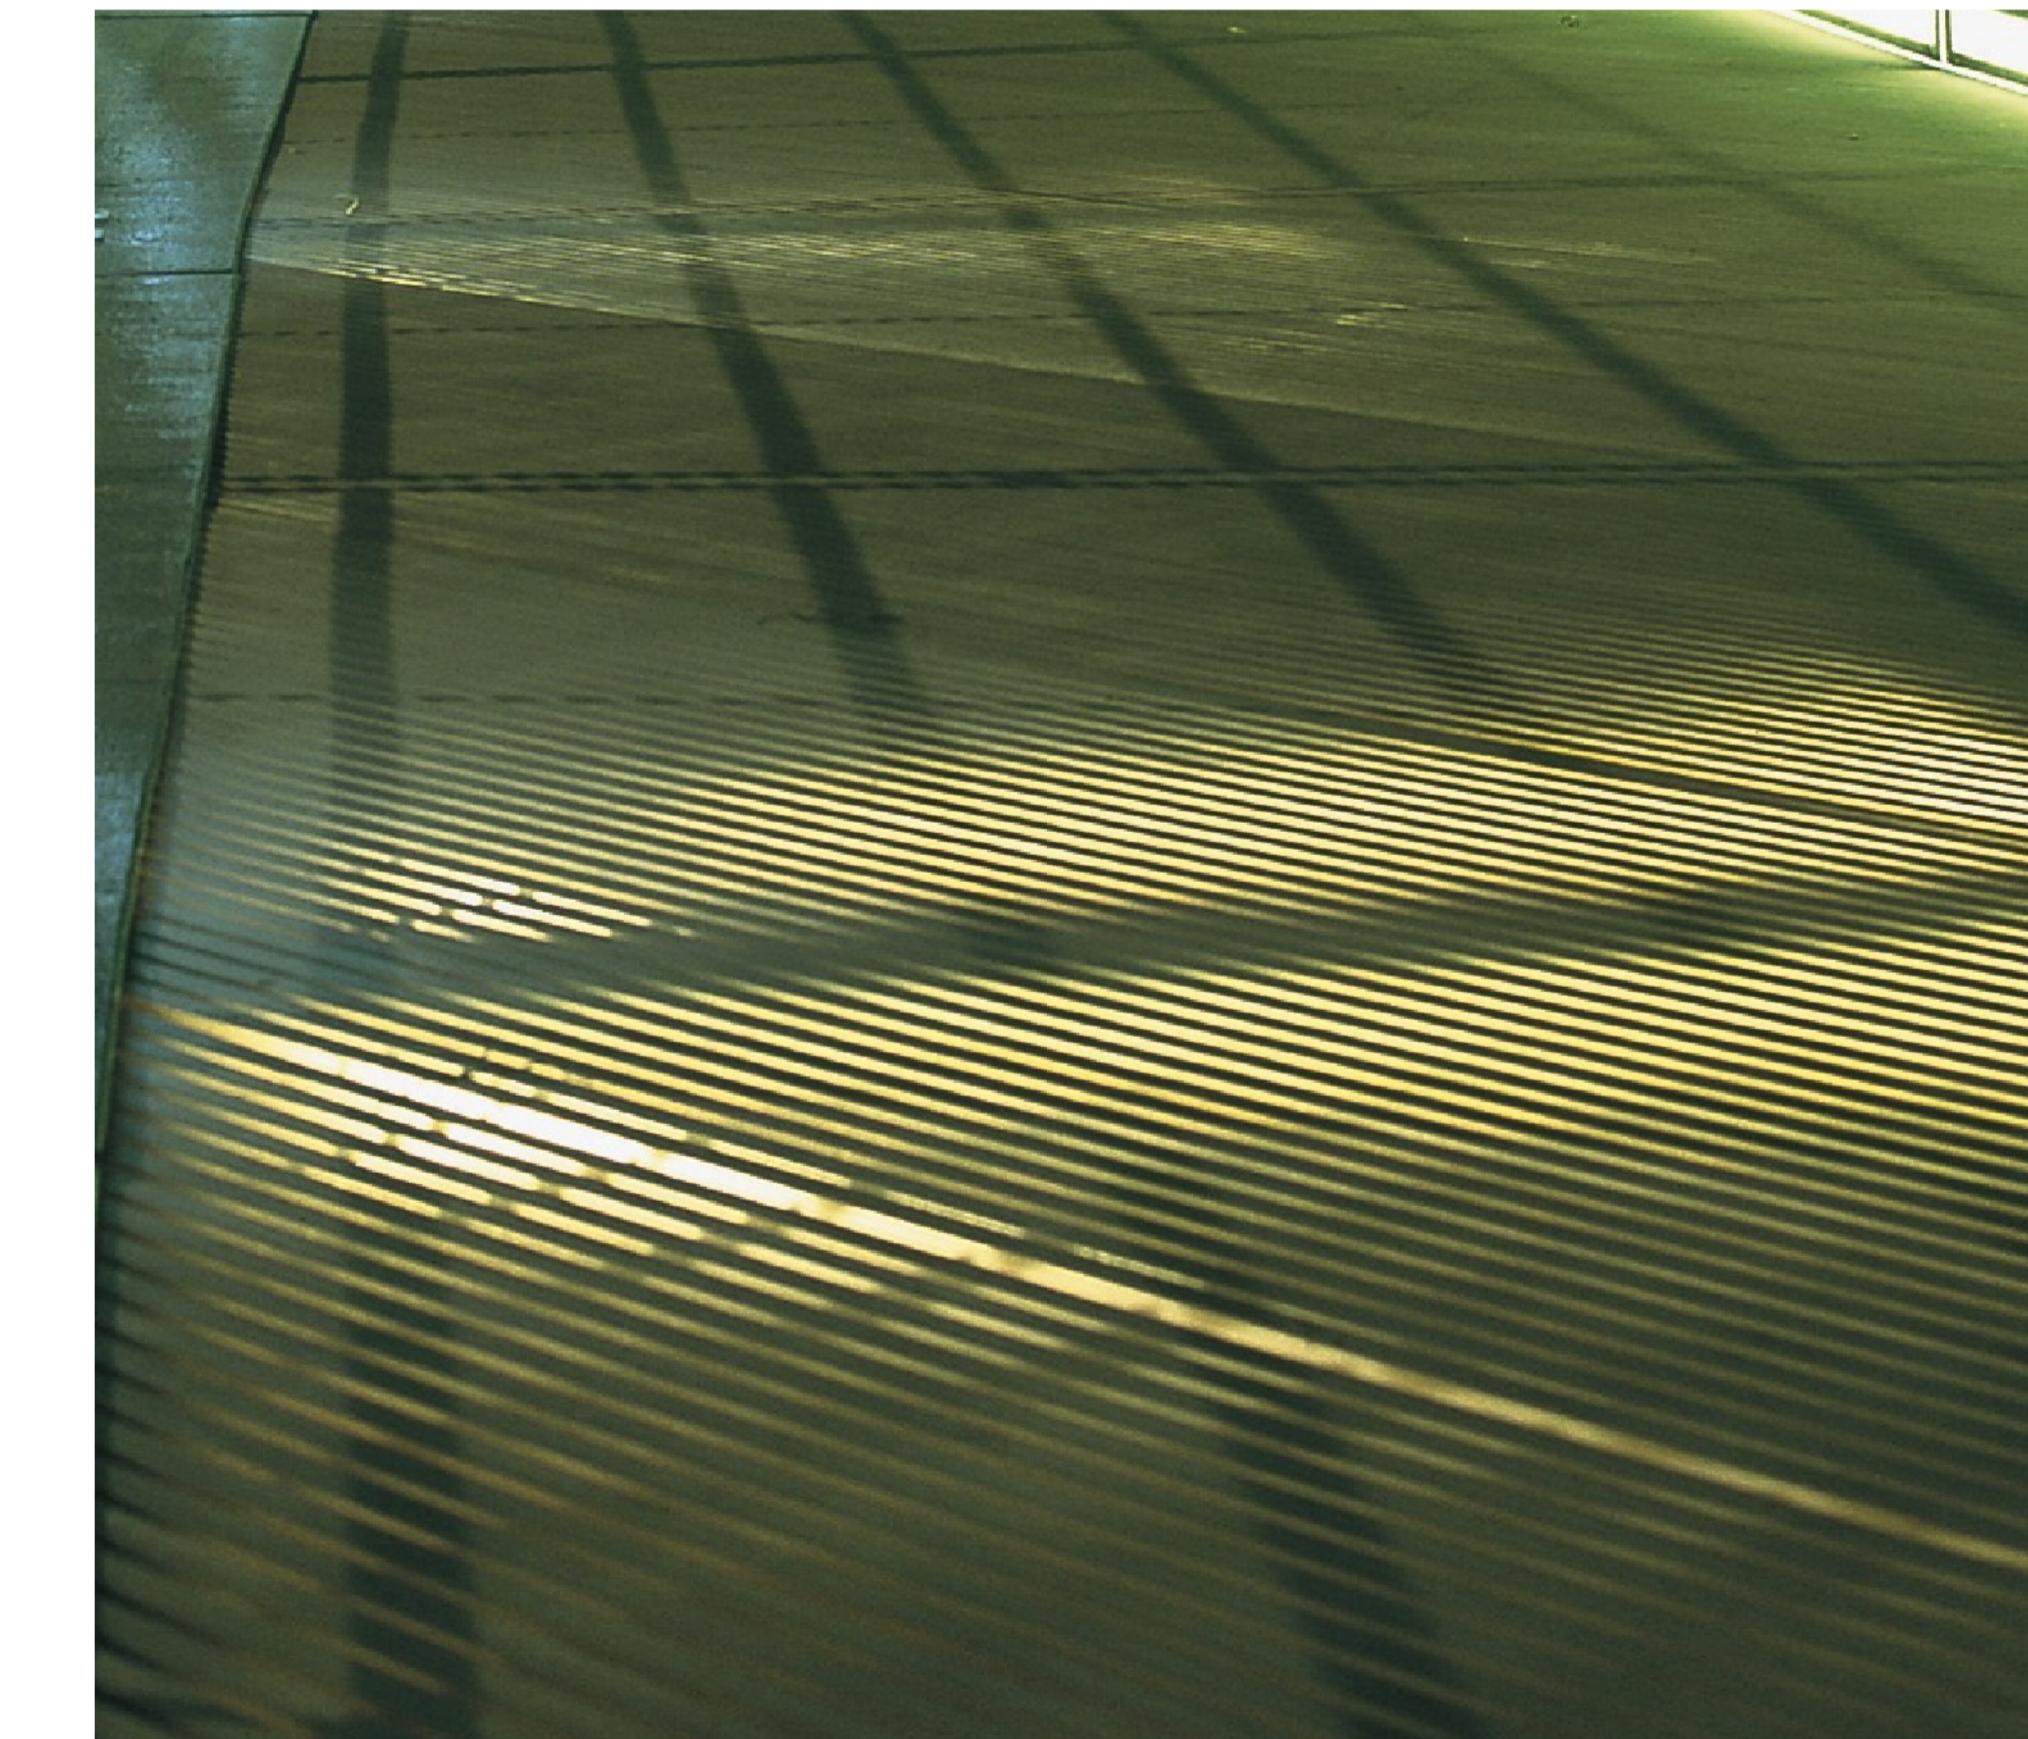

UNDER-GRILLE LIGHTING

Rev	Date	Description	By	Chkd	
-	-	-	-	-	Do not Scale. Use figured dimensions only. All dimensions to be checked on site
-	-	-	-	-	All drawings to be read in conjunction with the Engineers' drawings. Any discrepancies between consultants drawings to be reported to the Architect before any work commences.
-	-	-	-	-	The Contractor's attention is drawn to the Health & Safety matters identified in the Health & Safety plan as being potentially hazardous. These items should not be considered as a complete and final list. The Work Package Contractor's normal Health and Safety obligations still apply when undertaking constructional operations both on and off site.
-	-	-	-	-	
-	-	-	-	-	
-	-	-	-	-	
-	-	-	-	-	
-	-	-	-	-	

1. **What is the primary purpose of the study?** The study aims to evaluate the effectiveness of a new treatment for hypertension in a diverse population.

2. **What are the key variables being measured?** The primary outcome is blood pressure reduction, measured at baseline, 3 months, and 6 months. Secondary outcomes include changes in heart rate, blood glucose levels, and lipid profiles.

3. **What is the study design?** The study is a randomized controlled trial (RCT) comparing the new treatment (Group A) against a standard treatment (Group B). Both groups will receive the same diet and exercise interventions.

4. **What is the study population?** The study population consists of 1000 adults aged 30-60 years with hypertension, recruited from three different geographic areas: urban, suburban, and rural.

5. **What is the study duration?** The study duration is 6 months, with a 12-month follow-up period for the primary outcome.

6. **What is the study setting?** The study will be conducted in three medical centers located in the three geographic areas.

7. **What is the study protocol?** The study protocol includes a 2-week run-in period, followed by a 6-month treatment period, and a 12-month follow-up period. The treatment period will be divided into three 2-month intervals, with a 1-month break between intervals.

8. **What is the study sample size?** The study sample size is 1000 participants, with 500 assigned to Group A and 500 assigned to Group B.

9. **What is the study power?** The study power is 80%, with a significance level of 0.05.

10. **What is the study significance?** The study significance is to determine the effectiveness of the new treatment for hypertension in a diverse population.

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WilkinsonEyre

Project
Harley Street Bridge
Drawing Title
Material Precedents